CONSTRUCTION PLANS

DRWN. CHKD.

ROADWAY IMPROVEMENTS TO PELICAN DRIVE FROM ROAD 'B' TO THE CUL-DE-SAC in the

BOROUGH OF AUDUBON PARK CAMDEN COUNTY, NEW JERSEY

(KEI#40-40AP0521)

General Construction Notes:

Soil Erosion Notes:

the construction plans.

County Engineer's satisfaction.

(NO SPECIFIC PAYMENT WILL BE MADE FOR SOIL EROSION AND SEDIMENT CONTROL, THE PRICE FOR ALL SOIL EROSION AND SEDIMENT CONTROL SHALL BE INCLUDED IN THE PRICE OF VARIOUS ITEMS IN THE PROPOSAL.)

Contractor shall install all soil erosion and sediment control

New Jersey adopted in July 1999 and as amended.

Standards, including details of anchoring mulch.

is compacted the area must be retilled.

distribute 70 to 90 lbs. within each section.

performed to keep all areas damp and dust free.

tons per acre, according to State Standards.

Soil Erosion and Sediment Control in New Jersey.

protection until seeding is established.

(15) days of preliminary grading.

(i.e.: slopes greater than 3:1).

per acre, according to State Standards.

recommendations in Table 3.1.1

measures necessary of site; i.e. sediment barrier for soil retention, inlet protection structures, dust control, etc. All soil erosion and sediment control measures shall be in compliance with Chapter 3

and 4 of the Standards for Soil Erosion and Sediment Control in

All soil erosion and sediment control measures shall be installed before all other work on the site, at the locations as noted on

3. All erosion and sediment control practices shall be left in place

with the Soil Conservation District recommendations and to the

4. Stabilization with Mulch Only — When seasons and other conditions are not suitable for growing an erosion—resistant cover (November

1st through April 1st, and May 15th through August 15th) all exposed areas will be stabilized with mulch, salt hay or straw

and will be applied at a rate of 80%/2,000 S.F. and anchored

. Permanent vegetation cover— After final grading is completed a

6. Sodding placed in accordance with Sections 806, 810, 813 & 909

Temporary Vegetation Cover — Temporarily stabilize the soil and

of the N.J.D.O.T. Standard Specifications with a 1-2-2 ratio fertilizer, applied at a rate necessary to yield 50 pounds of nitrogen per acre.

reduce damage from wind and water erosion until permanent stabilization

is accomplished. Apply limestone and fertilizer according to soil test

recommendations. Fertilizer may be applied at the rate of 500 lbs

Apply limestone (equivalent to 50% calcium plus magnesium oxides)

fertilizer into the soil to a depth of 4" with a disc, spring tooth harrow, or other suitable tool. Inspect seedbed just before seeding. If the soil

per acre or 11 lbs. per 1,000 S.F. of 10-20-10 or equivalent.

as follows: 2 tons per acre to 90 lbs. per S.F. Work lime and

mulched only, see Standards p. 3.3.1. For temporary seeding, see

unrotten small grain straw, hay free of seeds or salt hay to be

liquid mulch-binder (tackifying or adhesive agent), the rate of

applied at the rage of 1-1/2-2 tons per acre (70 to 90 lbs. per

1,000 S.F.), except that where a crimper is used instead of a

application must be double the lower rate. Mulch chopper-blowers must not grind the material. Spread uniformly by hand or

10. Dust Control— The contractor shall prevent movement and/or blowing

shall consist of mulches, spray-on adhesives, calcium chloride, sprinkling with water, street sweeping or other methods approved by

11. All soil erosion and sediment control practices to be installed

prior to any major soil disturbances, or in their proper

12. Any disturbed area that will be left exposed more than thirty

receive a temporary seeding. If the season prevents the

the Engineer and/or Soil Conservation District. The contractor shall

sequence, and maintained until permanent protection is established.

(30) days and not subject to construction traffic, will immediately

establishment of a temporary cover, the disturbed area will be

mulched with straw, or equivalent material, at a rate of two (2)

13. Permanent vegetation to be seeded or hydroseeded on all exposed

14. All work to be done in accordance with the State Standards for

grading and installation of improvements in order to stabilize

critical areas subject to erosion (i.e.: steep slopes, roadway

embankments) will receive a temporary seeding in combination with straw mulch or a suitable equivalent, at a rate of two (2) tons

streets, roads, driveways and parking areas. In areas where no utilities are present, the subbase shall be installed within fifteen

15. A subbase course will be applied immediately following rough

16. Immediately following initial disturbance or rough grading all

17. Any steep slopes receiving pipeline installation will be back—

Camden County Soil Conservation District and the Engineer.

having a pH of 5 or more prior to seedbed preparation.

20. The Camden County Soil Conservation District shall be notified

21. At the time when the site preparation for permanent vegetative

stabilization is going to be accomplished, any soil that will not

seventy—two (72) hours in advance of any land disturbing activity

filled and stabilized daily, as the installation proceeds,

18. The contractor shall utilize the roadways as a construction entrance

19. In accordance with the Standards for Permanent Vegetative Cover

iron sulfides shall be covered with a minimum of 12" of soil

The existing roadways shall be cleaned as needed & directed by the

for Soil Stabilization, any soil having a pH of 4 or less or containing

areas within two (2) days after final grading. Mulch will be used for

clean the roadway as needed and directed by the engineer and/or the

Soil Conservation District. In conjunction with cleaning, the contractor shall be required to sprinkle areas with water or another approved method shall be

of dust from exposed soil surface. This requirement is to reduce damage.

4.10.1 of the standards for Soil Erosion and Sediment Control and section

107.28 of the N.J.D.O.T. Standard Specifications. Methods for dust control

health hazards and improve traffic safety, in accordance with section

3. Soils high in sulfides or having a pH of 4 or less should be

. Mulching is required on all seeding. Mulch materials should be

mechanically so that approximately 1,000 S.F. sections and

consisting of the following in the areas designated on the construction

permanent vegetative cover will be used to stabilize the soil

immediately after placement to minimize loss by wind or water. Stabilization with mulch will comply with Section 3.31 of said

until construction is complete or the area is stabilized in accordance

(PARTIALLY FUNDED THROUGH THE N.J.D.O.T. MUNICIPAL AID PROGRAM, FY2022)

PROJECT LENGTH 315 L.F. ±/ 0.059 MILES ±

- 1. All clearing items (trees, brush, stumps, concrete, etc.) shall be removed from the project and disposed of at a lawful disposal site to be furnished by the Contractor, at his expense.
- 2. The Contractor shall procure all required permits, licenses and inspections. Contractor shall be responsible for all charges and fees as well as, give notices necessary for all incidentals for project. Soil Conservation Permits shall be obtained by the Municipality at no cost to the Contractor.
- 3. All construction debris (asphalt, concrete, etc.) must be removed from the project site prior to the end of each day to eliminate any potential hazards. There will be no specific payment for this item, cost to be
- 4. All demolition / removal items (concrete, asphalt, etc.) shall be removed from the project and disposed of at a lawful disposal site, provided by the Contractor, at his expense.
- 5. Excess excavated materials shall be delivered to a lawful site location, provided by the Contractor at his
- 6. The quantities of all asphalt or concrete, which is to be recycled, must be reported to the Municipality and
- 7. All areas disturbed/damaged by the Contractor, shall be returned to its original condition or better, by the
- 8. The location of all existing utility lines, mains, services, appurtenances must be verified by the Contractor prior to the commencement of construction. The Contractor shall perform test pits in the presence of the Construction Engineer. The Contractor shall be responsible for the repair of any damage caused by his

operations. He shall notify the respective utility company for location markout prior to any excavation and

- 9. The Contractor is required to perform the proper notification of New Jersey One Call Center (formerly the Garden State Underground Plant Location Service) prior to excavation for the purpose of identifying the location of underground facilities. This requirement is in accordance with the Underground Facilities Protection Act (P.L. 1994 c. 118). Any and all utilities not subscribing to the New Jersey One — Call Center shall be contacted individually. No work shall commence without proper notifications and verification of all
- 10. All Utility Contractors shall procure all required permits, licenses and inspections, pay all charges and give notices necessary for all incidentals to the due and lawful prosecution of the project.
- 11. The Contractor shall be responsible for properly backfilling and compacting all trenches. No trenches shall be left open after construction hours for the day. All construction areas are to be kept in a condition that allows for safe movement of all vehicular and pedestrian traffic.
- 12. All areas adjacent to newly constructed concrete curbing, sidewalk, etc., shall be backfilled to finished grade prior to the end of each day to eliminate any potential hazards. There will be no specific payment for this item, cost to be included in the price for various items in the Proposal.
- 13. In accordance with the "Maintenance and Protection of Pedestrian and Vehicular traffic" specification, the Contractor shall maintain "two (2) lanes of traffic, a minimum of 10 feet wide each, during all other hours." The Contractor shall provide the Engineer with a Staging Plan with the proper traffic control measures to protect both pedestrian and vehicular traffic, during all other hours. The Staging Plan shall be submitted to the Engineer and Chief of Police at the Preconstruction Meeting.
- 14. All areas of disturbance shall be graded so as to eliminate any mounds and/or depressions prior the end of each day to eliminate any potential hazards. There will be no specific payment for this item, cost to be included in the price for various items, in the Proposal.
- 15. Barricades, lighting devices and other traffic control devices shall be placed in accordance with and shall conform to Section 110, New Jersey Department of Transportation Traffic Control Standard Specifications for Road and Bridge Construction, Part 6 of the M.U.T.C.D. and Work Zone Traffic Control (US Department of
- 16. Traffic/ pedestrian control devices and equipment shall be placed in accordance with all applicable Federal,
- 17. All concrete curb and sidewalk designated for removal, shall be taken from the nearest joint, as necessary, to install proposed improvements
- 18. Where no joints exist on concrete drives or sidewalk, the edge shall be sawcut along straight lines before

Inspector's overtime. The hours of operation shall be from 7:00 a.m. to 4:00 p.m.

- 19. Pavement shall be sawcut vertically, along straight lines, before excavating. Where new pavement meets existing pavement the joint shall be sealed with an approved joint sealer. There will be no specific payment for this item, joint sealer. The cost shall be included in the price for various items, in the Proposal.
- 20. The Contractor must request grade stakes at least ten (10) days prior to the start of construction. Failure to provide proper notice may result in construction delays, with no compensation for construction delays
- 21. The Contractor shall not be permitted to work on Saturdays, Sundays or holidays. Should the Contractor obtain permission from the Municipality to do so, he shall be required to pay the Engineer for the
- 22. Inspections or failures to inspect any materials or workmanship by Municipal Officials shall in no way relieve the contractor of his responsibilities to perform the work in accordance with applicable plans, specifications
- 23. All concrete shall be N.J.D.O.T. Class 'B'.

construction for all items for review by the Engineer.

- 24. All signs which are removed during construction shall be reset either temporarily or permanently prior to the end of each day. There will be no specific payment for this item, cost to be included in the price of various
- 25. The Contractor must utilize a trench box where necessary, in accordance with the U.S. Department of Labor, Occupational Safety and Health Administration, 1990, revised (29CFR Part 1926).
- 26. Temporary line striping shall be provided in order to maintain traffic flow, safety and convenient passage of traffic through project. A minimum of a 10' wide lane in each direction shall be provided during construction (NO SPECIFIC PAYMENT) <u>DETOURING OF TRAFFIC SHALL NOT BE PERMITTED UNLESS APPROVED BY THE CHIEF OF POLICE.</u> Should Police Traffic Directors be required, their services shall be paid for by the Municipality at no cost to the Contractor.
- 27. The Contractor shall be required to coordinate his work with any and all utility companies in order to eliminate any conflicts and/or delays.
- 28. The General Contractor is Designated as the "Responsible Person in Charge of Construction" and the site supervisor responsible for construction site safety during the course of site improvements pursuant to N.J.A.C. 5: 23-2.21 (c) and (d) of the N.J. Uniform Construction Code.
- 29. The Contractor shall comply with the Public Works Contractor Registration Act (P.L. 1999, c. 238 N.J.S.A. 34:11 - 56.48 etseq.) & New Jersey Business Registration Requirements of Public Contractors (N.J.S.A.
- 30. The Contractor shall provide 2 copies of submittals two (2) weeks prior to the commencement of
- 31. The Contractor shall video record, with audio description, the entire project limits to document the site conditions and provide two (2) CD or DVD copies to the Engineer.
- 32. The Contractor shall not be permitted to deny access to or enter onto any residential property without the written permission of the property owner. The Contractor shall take all measures to perform the construction
- 33. Failure of the Contractor to follow the directions of the Engineer and/or his representatives may result in a "STOP WORK" order. Should a "STOP WORK" order be issued, the Contractor shall incur all expenses to secure the job site and remobilization costs when authorized by the Engineer to recommence.

Utility Companies:

Audubon Mutual Housing Corporation Audubon Park, NJ 08106

ATTN: Mr. Ken Whalen, Maintenance Supervisor New Jersey American Water Company

204 Carriage Lane Delran. NJ 08075

Camden County MUA 1645 Ferry Avenue

P.S.E.G. Services Corporation Gas Distribution Department 535 Nicholson Road

P.S.E.G. Services Corporation Construction Inquiry Center

Audubon, NJ 08106

410 Route 130 South Bordentown, NJ 08505

> Comcast Cable Communications, Inc. 1250 Haddonfield-Berlin Road

Post Office Box 502. Cherry Hill NJ 08034

10 Tansboro Road Berlin NJ 08009

Audubon Park

Sheet List Table Sheet Title Cover Sheet Construction Plan and Profile Intersection Grading Plan Cul-De-Sac Grading Plan

Details

DATE: 02/06/23 | DRAWN BY: S.H./ T.H. | CHKD. BY: PROJECT No. 40-40AP0521 FIELD BOOK/PAGE: GREGORY BLASE FUSCO NJPE No. 32853 NJ PROFESSIONAL PLANNER No. 4076

REV. DATE:

BERLIN, NEW JERSEY 08009-2399 CERTIFICATE OF AUTHORIZATION #24GA28041300

Cover Sheet

Roadway Improvements to Pelican Drive from

Road 'B' to the Cul-De-Sac

Borough of Audubon Park


Camden County, New Jersey

PROFESSIONAL ENGINEER

PA.PF No. 036608-F

CONSTRUCTION AND MATERIALS SHALL CONFORM TO THE DEPARTMENT'S STANDARD SPECIFICATIONS FOR ROAD AND BRIDGE CONSTRUCTION, 2019 EDITION, WHICH IS INCORPORATED HEREIN BY REFERENCE, AS AMENDED AND SUPPLEMENTED. AND THE DEPARTMENT'S SUPPLEMENTARY SPECIFICATIONS FOR STATE AID PROJECTS. 2019 EDITION. WHICH IS INCORPORATED HEREIN BY REFERENCE. AS AMENDED AND SUPPLEMENTED. STANDARD CONSTRUCTION DETAILS SHALL CONFORM TO THE LATEST REQUIREMENTS OF THE DEPARTMENT OF TRANSPORTATION. THE NEW JERSEY DEPARTMENT OF TRANSPORTATION "STANDARD ROADWAY CONSTRUCTION/ TRAFFIC CONTROL/ BRIDGE CONSTRUCTION DETAILS" BOOKLET DATED 2016 AND "ELECTRICAL BUREAU STANDARD DETAILS, 2007" AND ALL BASELINE DOCUMENT CHANGES MADE TO THESE CONSTRUCTION DETAILS, SHALL GOVERN, EXCEPT FOR THOSE DETAILS CONTAINED HEREIN. PARTIALLY FUNDED THROUGH NEW JERSEY DEPARTMENT OF TRANSPORTATION MUNICIPAL AID PROGRAM, FY2022

REPRODUCTION, ALTERATION AND AMENDMENT OF THIS PLAN SHALL BE PERFORMED ONLY BY KEY ENGINEERS. INC. AND SHALL BE PERFORMED UNDER THE ABSOLUTE DIRECTION OF THE LICENSEL PROFESSIONAL WHOSE NAME AND SIGNATURE APPEARS HEREON.

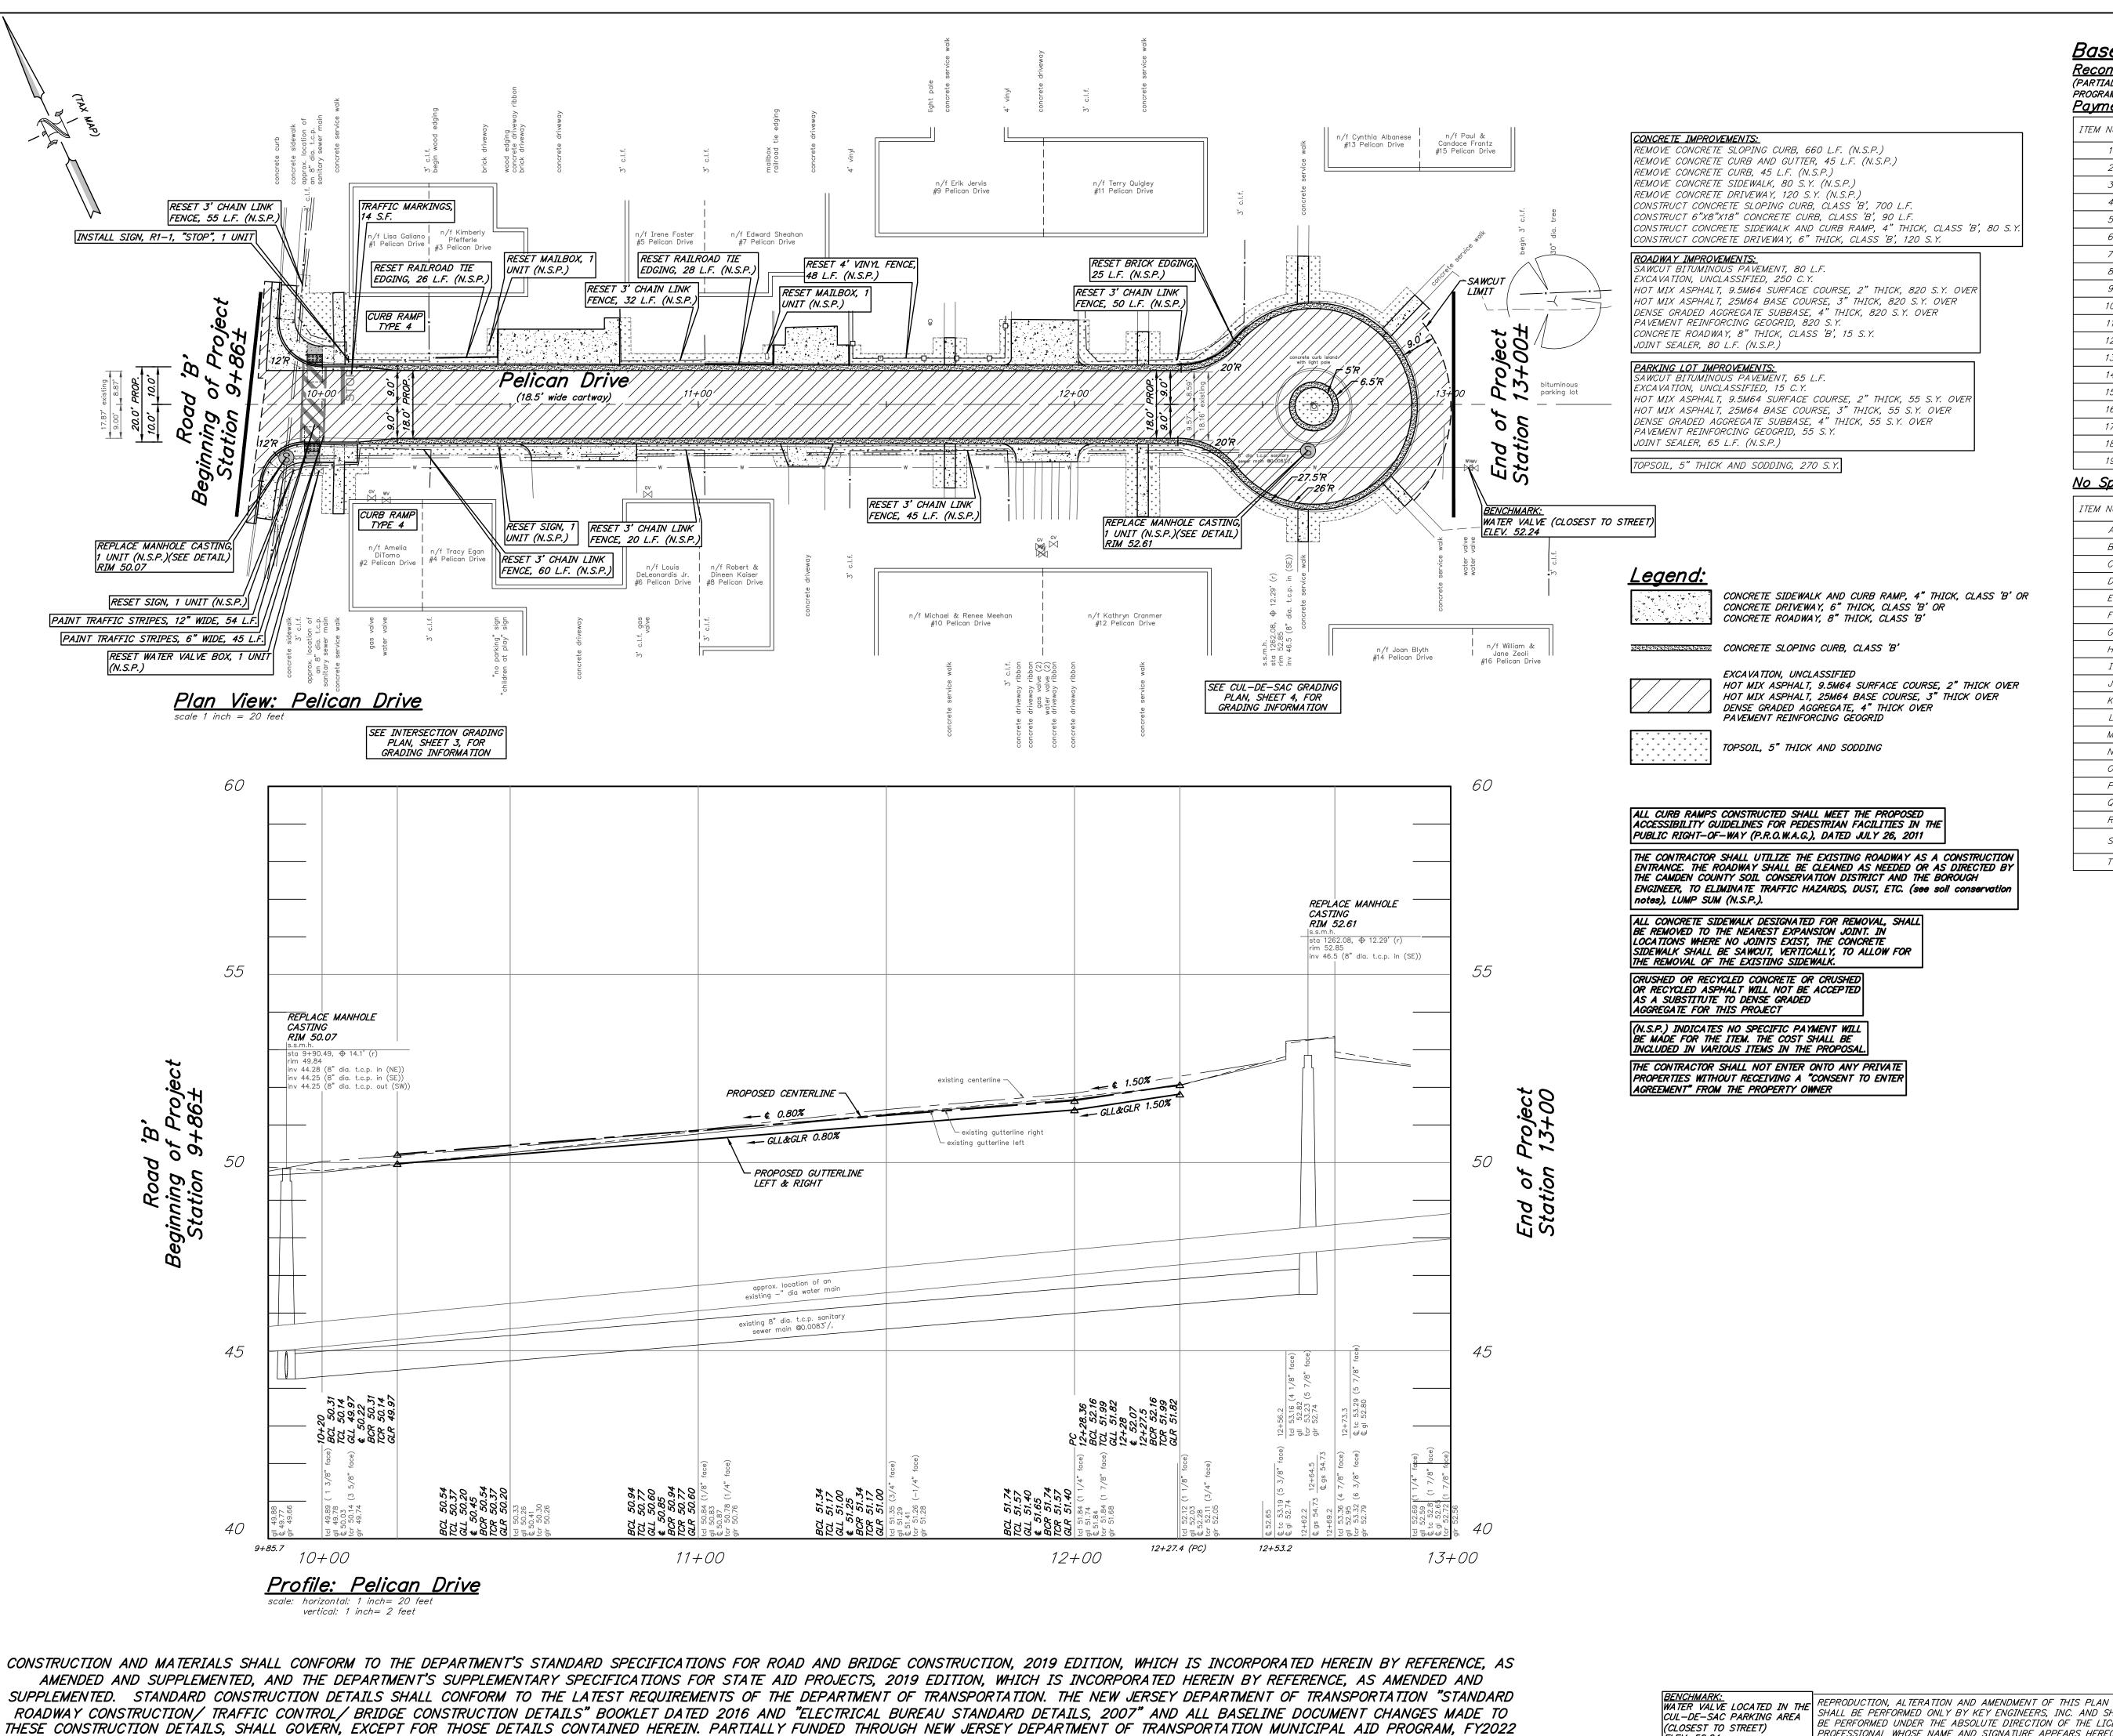

Base Bid:

Reconstruction of Pelican Drive From Road 'B' to the Cul-De-Sac (PARTIALLY FUNDED THROUGH THE NEW JERSEY DEPARTMENT OF TRANSPORTATION MUNICIPAL AID

PROGRAM, FY2022) Payment Items:

ITEM NUMBER	DESCRIPTION	UNIT MEASURED	QUANTITY
1	SAWCUT BITUMINOUS PAVEMENT	L.F.	145
2	EXCAVATION, UNCLASSIFIED	C. Y.	265
3	CONCRETE SLOPING CURB, CLASS 'B'	L.F.	700
4	6"X8"X18" CONCRETE CURB, CLASS 'B'	L.F.	90
5	CONCRETE SIDEWALK AND CURB RAMP, 4" THICK, CLASS 'B'	S. Y.	80
6	CONCRETE DRIVEWAY, 6" THICK, CLASS 'B'	S. Y.	120
7	CONCRETE ROADWAY, 8" THICK, CLASS 'B'	S. Y.	15
8	PAVEMENT REINFORCING GEOGRID	S. Y.	875
9	DENSE GRADED AGGREGATE SUBBASE, 4" THICK	S. Y.	<i>875</i>
10	HOT MIX ASPHALT, 25M64 BASE COURSE, 3" THICK	S. Y.	875
11	HOT MIX ASPHALT, 9.5M64, SURFACE COURSE, 2" THICK	S. Y.	<i>875</i>
12	DETECTABLE WARNING SURFACE	S.F.	16
13	TOPSOIL, 5" THICK AND SODDING	S. Y.	270
14	SIGN	UNIT	1
15	TRAFFIC STRIPES, 6" WIDE	L.F.	<i>45</i>
16	TRAFFIC STRIPES, 12" WIDE	L.F.	54
17	TRAFFIC MARKINGS	S.F.	14
18	ASPHALT PRICE ADJUSTMENT	L.S.	L.S.
19	FUEL PRICE ADJUSTMENT	L.S.	L. S.

No Specific Payment Items:

ITEM NUMBER	DESCRIPTION	UNIT MEASURED	QUANTITY
А	SOIL EROSION AND SEDIMENT CONTROL	N.S.P.	N.S.P.
В	REMOVE CONCRETE SLOPING CURB	L.F.	660
С	REMOVE CONCRETE CURB AND GUTTER	L.F.	45
D	REMOVE CONCRETE CURB	L.F.	45
E	REMOVE CONCRETE SIDEWALK	S. Y.	80
F	REMOVE CONCRETE DRIVEWAY	S. Y.	120
G	REPLACE MANHOLE CASTING	UNIT	2
Н	RESET WATER VALVE BOX	UNIT	1
I	RESET SIGN	UNIT	2
J	RESET MAILBOX	UNIT	2
K	RESET RAILROAD TIE EDGING	L.F.	54
L	RESET 3' HIGH CHAIN LINK FENCE	L.F.	262
М	RESET 4' HIGH VINYL FENCE	L.F.	48
N	RESET BRICK EDGING	L.F.	25
0	JOINT SEALER	L.F.	145
Р	CONCRETE SEALING	N.S.P.	N.S.P.
Q	DEWATERING	N.S.P.	N.S.P.
R	WA TERING	N.S.P.	N.S.P.
S	MAINTENANCE AND PROTECTION OF VEHICULAR AND PEDESTRIAN TRAFFIC	N.S.P.	N.S.P.
T	N.J.D.O.T. CIVIL RIGHTS SIGN	UNIT	1

REV. DATE: DESCRIPTION

Construction Plan and Profile

Reconstruction of Pelican Drive from Road 'B' to the Cul-De-Sac Station 9+86± to Station 13+00


Borough of Audubon Park Camden County, New Jersey

 DATE:
 02/06/23
 DRAWN BY:
 S.H./ T.H.
 CHKD. BY:

 PROJECT No. 40-40AP0521
 FIELD BOOK/PAGE:
 SH
 SCALE: AS NOTED

GREGORY BLASE FUSCO PROFESSIONAL ENGINEER


NJPE No. 32853 PA.PE No. 036608-E NJ PROFESSIONAL PLANNER No. 4076

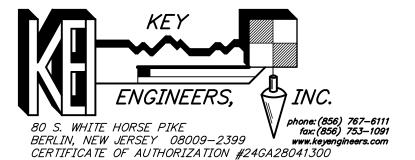

CUL-DE-SAC PARKING AREA (CLOSEST TO STREET)

SHALL BE PERFORMED ONLY BY KEY ENGINEERS, INC. AND SHALL BE PERFORMED UNDER THE ABSOLUTE DIRECTION OF THE LICENSED PROFESSIONAL WHOSE NAME AND SIGNATURE APPEARS HEREON.


DRWN. CHKD.

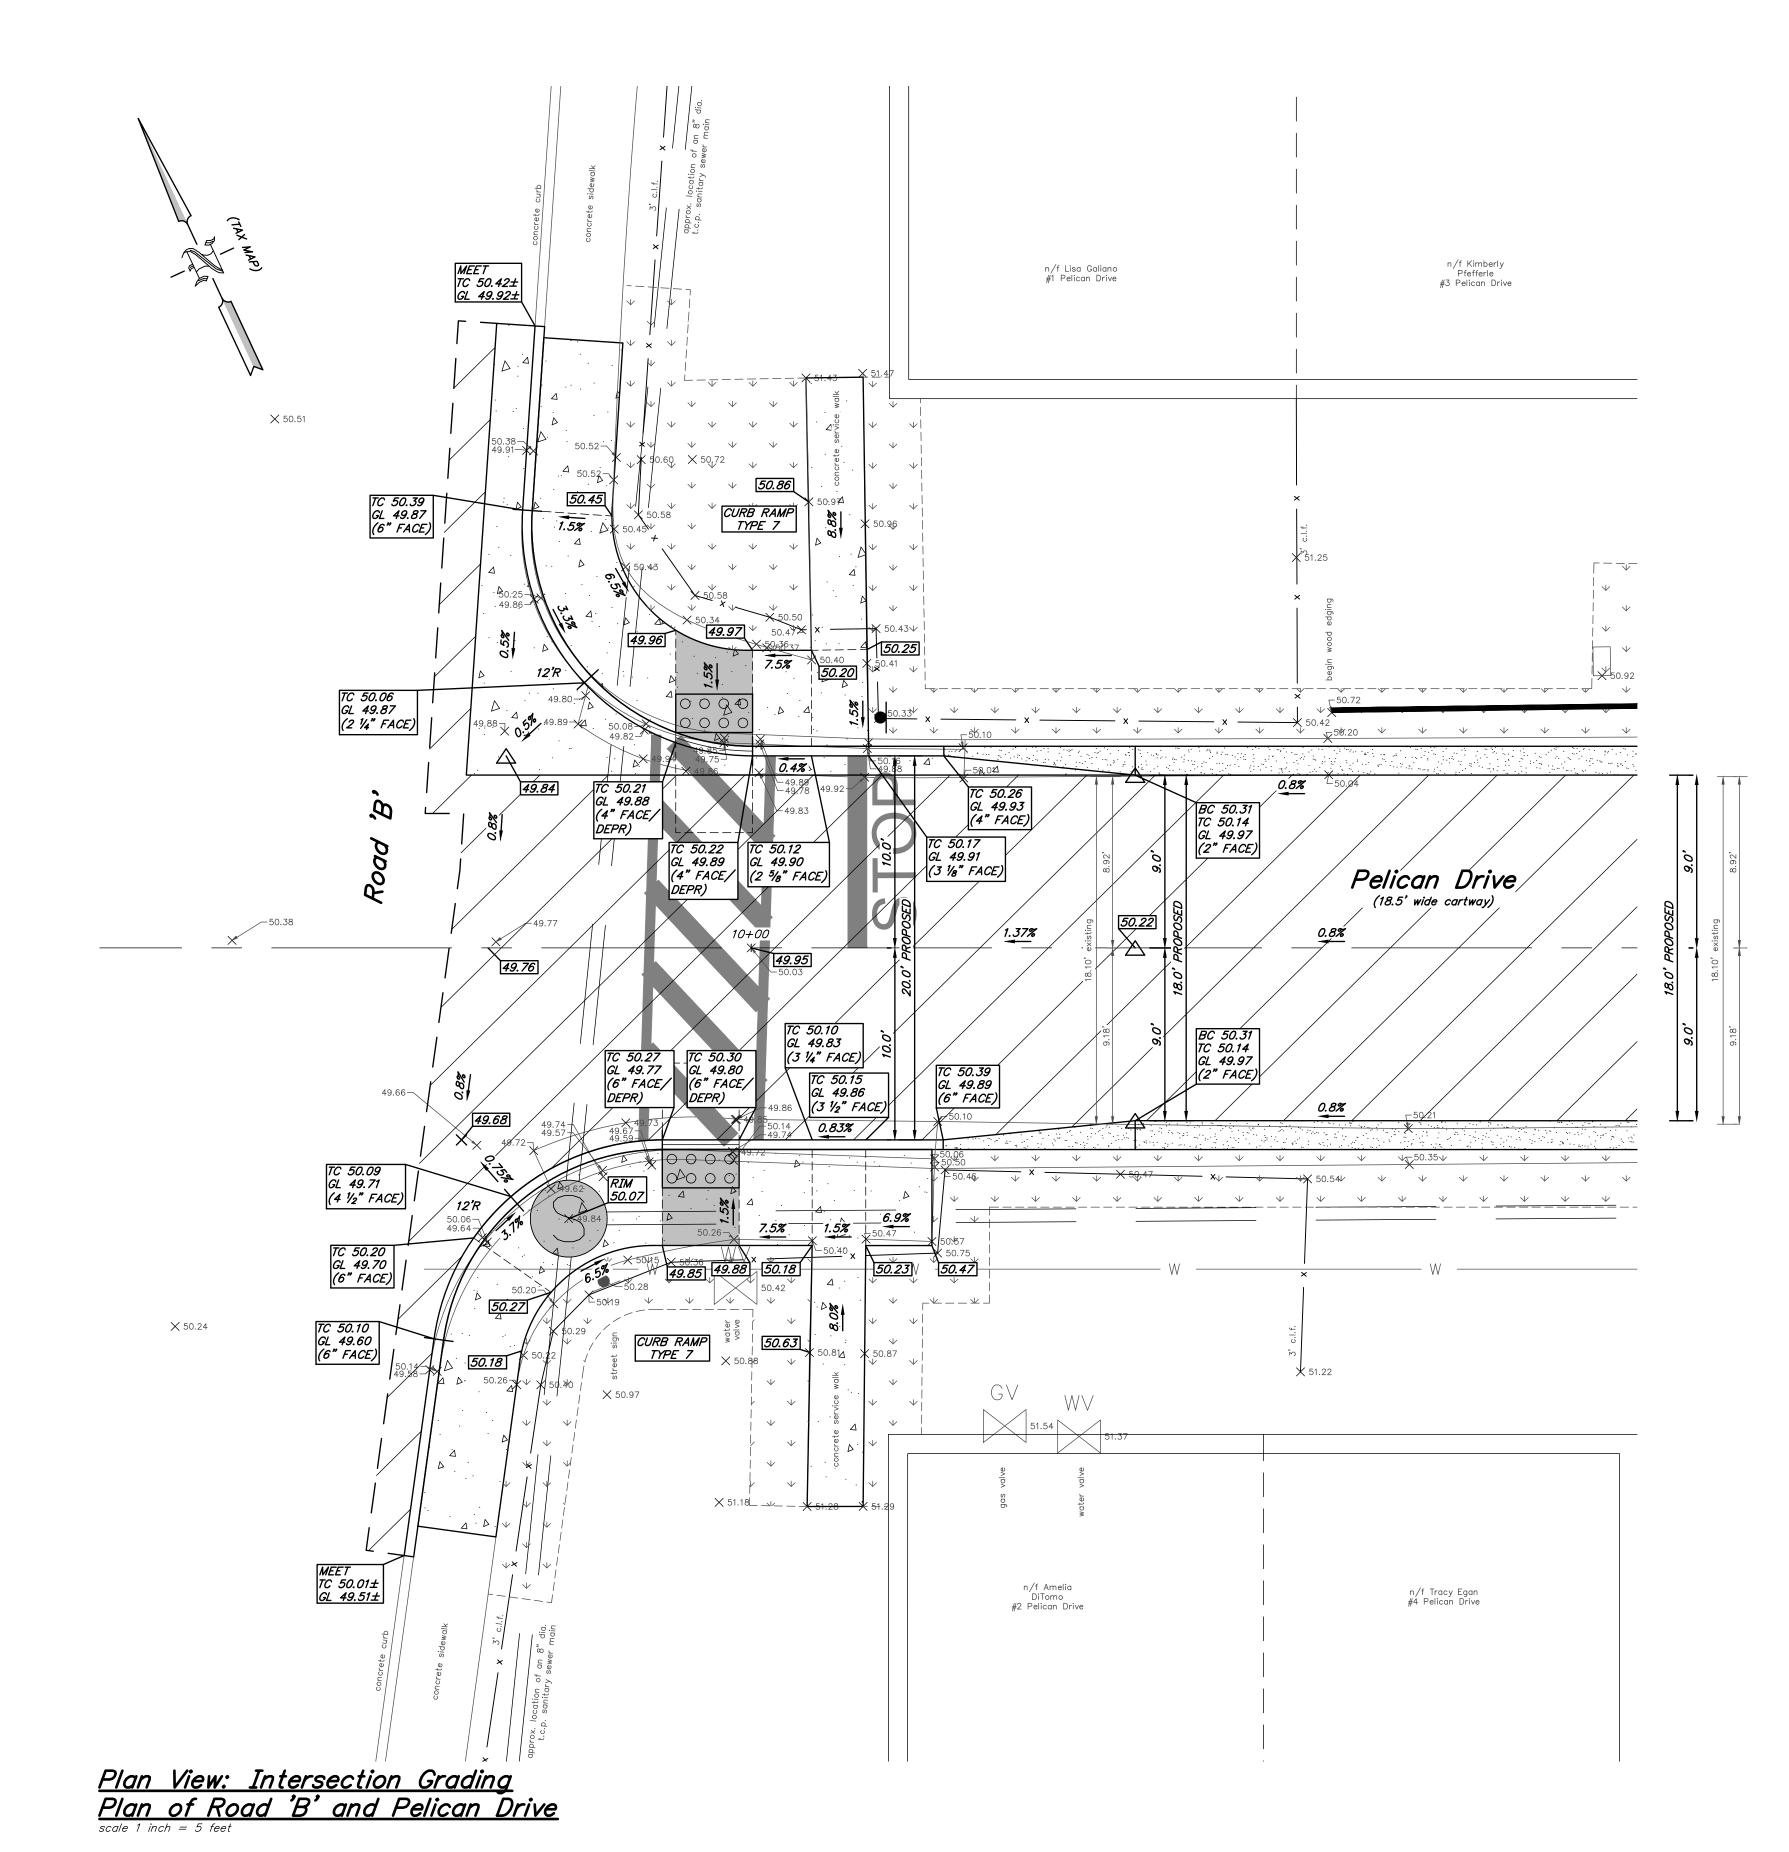


Legend:

CONCRETE SIDEWALK AND CURB RAMP, 4" THICK, CLASS 'B' OR CONCRETE DRIVEWAY, 6" THICK, CLASS 'B' OR CONCRETE ROADWAY, 8" THICK, CLASS 'B'

CONCRETE SLOPING CURB, CLASS 'B'

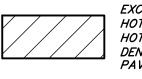

EXCAVATION, UNCLASSIFIED HOT MIX ASPHALT, 9.5M64 SURFACE COURSE, 2" THICK OVER HOT MIX ASPHALT, 25M64 BASE COURSE, 3" THICK OVER DENSE GRADED AGGREGATE, 4" THICK OVER PAVEMENT REINFORCING GEOGRID

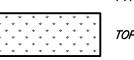

TOPSOIL, 5" THICK AND SODDING

ALL CURB RAMPS CONSTRUCTED SHALL MEET THE PROPOSED ACCESSIBILITY GUIDELINES FOR PEDESTRIAN FACILITIES IN THE PUBLIC RIGHT-OF-WAY (P.R.O.W.A.G.), DATED JULY 26, 2011

THE CONTRACTOR SHALL UTILIZE THE EXISTING ROADWAY AS A CONSTRUCTION ENTRANCE. THE ROADWAY SHALL BE CLEANED AS NEEDED OR AS DIRECTED BY THE CAMDEN COUNTY SOIL CONSERVATION DISTRICT AND THE BOROUGH ENGINEER, TO ELIMINATE TRAFFIC HAZARDS, DUST, ETC. (see soil conservation notes), LUMP SUM (N.S.P.).

ALL CONCRETE SIDEWALK DESIGNATED FOR REMOVAL, SHALL BE REMOVED TO THE NEAREST EXPANSION JOINT. IN LOCATIONS WHERE NO JOINTS EXIST, THE CONCRETE SIDEWALK SHALL BE SAWCUT, VERTICALLY, TO ALLOW FOR THE REMOVAL OF THE EXISTING SIDEWALK.

CRUSHED OR RECYCLED CONCRETE OR CRUSHED OR RECYCLED ASPHALT WILL NOT BE ACCEPTED AS A SUBSTITUTE TO DENSE GRADED AGGREGATE FOR THIS PROJECT

(N.S.P.) INDICATES NO SPECIFIC PAYMENT WILL BE MADE FOR THE ITEM. THE COST SHALL BE INCLUDED IN VARIOUS ITEMS IN THE PROPOSAL.

THE CONTRACTOR SHALL NOT ENTER ONTO ANY PRIVATE PROPERTIES WITHOUT RECEIVING A "CONSENT TO ENTER AGREEMENT" FROM THE PROPERTY OWNER

> REV. DATE: DRWN. CHKD.

Intersection Grading Plan

Reconstruction of Pelican Drive from Road 'B' to the Cul-De-Sac Station 9+50 to Station 13+60±


Borough of Audubon Park Camden County, New Jersey

 DATE: 02/06/23
 DRAWN BY: S.H./ T.H. | CHKD. BY:
 SCALE: AS NO

 PROJECT No. 40-40AP0521
 FIELD BOOK/PAGE:
 SHEET No. 3 OF 5

GREGORY BLASE FUSCO PROFESSIONAL ENGINEER

NJPE No. 32853 p. 32853 PA.PE No. 036608–E NJ PROFESSIONAL PLANNER No. 4076

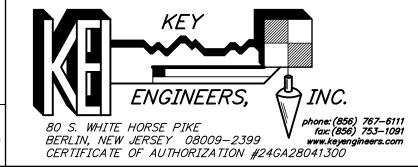


CONSTRUCTION AND MATERIALS SHALL CONFORM TO THE DEPARTMENT'S STANDARD SPECIFICATIONS FOR ROAD AND BRIDGE CONSTRUCTION, 2019 EDITION, WHICH IS INCORPORATED HEREIN BY REFERENCE, AS AMENDED AND SUPPLEMENTED, AND THE DEPARTMENT'S SUPPLEMENTARY SPECIFICATIONS FOR STATE AID PROJECTS, 2019 EDITION, WHICH IS INCORPORATED HEREIN BY REFERENCE, AS AMENDED AND SUPPLEMENTED. STANDARD CONSTRUCTION DETAILS SHALL CONFORM TO THE LATEST REQUIREMENTS OF THE DEPARTMENT OF TRANSPORTATION. THE NEW JERSEY DEPARTMENT OF TRANSPORTATION "STANDARD" ROADWAY CONSTRUCTION/ TRAFFIC CONTROL/ BRIDGE CONSTRUCTION DETAILS" BOOKLET DATED 2016 AND "ELECTRICAL BUREAU STANDARD DETAILS, 2007" AND ALL BASELINE DOCUMENT CHANGES MADE TO THESE CONSTRUCTION DETAILS, SHALL GOVERN, EXCEPT FOR THOSE DETAILS CONTAINED HEREIN. PARTIALLY FUNDED THROUGH NEW JERSEY DEPARTMENT OF TRANSPORTATION MUNICIPAL AID PROGRAM, FY2022

(CLOSEST TO STREET)

BENCHMARK:
WATER VALVE LOCATED IN THE
CUL-DE-SAC PARKING AREA

REPRODUCTION, ALTERATION AND AMENDMENT OF THIS PLAN
SHALL BE PERFORMED ONLY BY KEY ENGINEERS, INC. AND SHA SHALL BE PERFORMED ONLY BY KEY ENGINEERS, INC. AND SHALL BE PERFORMED UNDER THE ABSOLUTE DIRECTION OF THE LICENSED



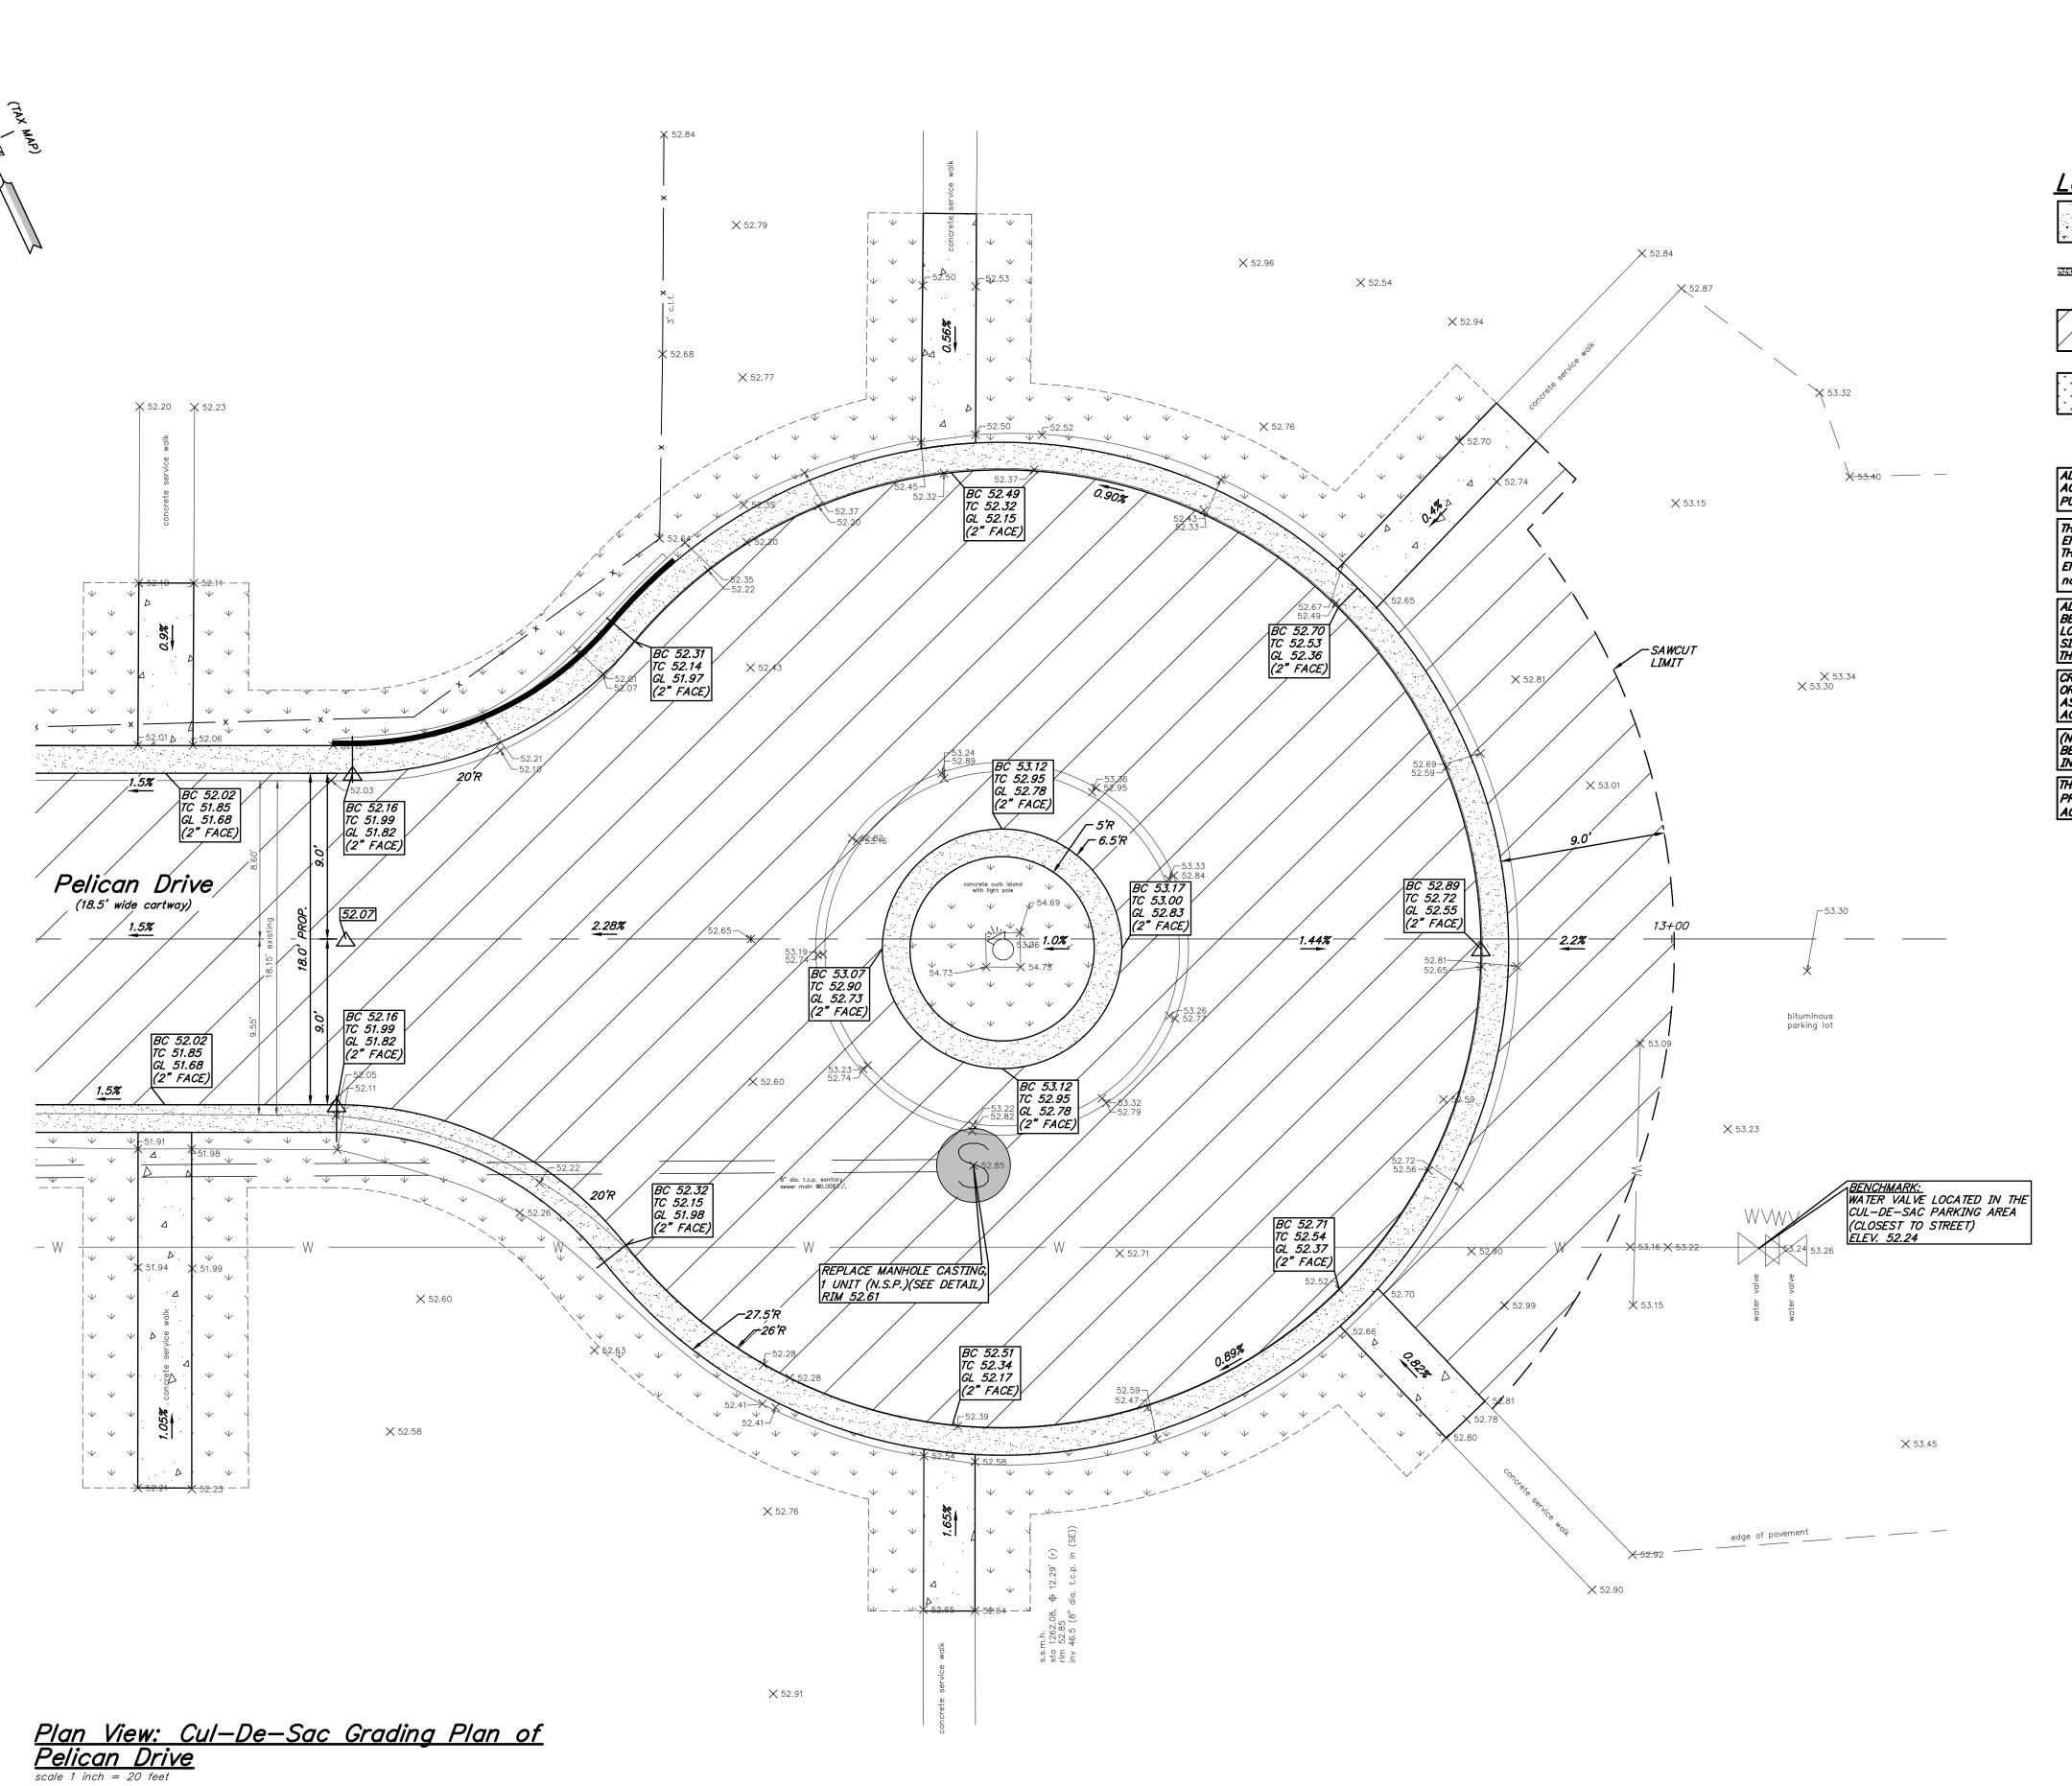

<u>Legend:</u>

CONCRETE SIDEWALK AND CURB RAMP, 4" THICK, CLASS 'B' OR CONCRETE DRIVEWAY, 6" THICK, CLASS 'B'

CONCRETE SLOPING CURB, CLASS 'B'

PAVEMENT REINFORCING GEOGRID

EXCAVATION, UNCLASSIFIED HOT MIX ASPHALT, 9.5M64 SURFACE COURSE, 2" THICK OVER HOT MIX ASPHALT, 25M64 BASE COURSE, 3" THICK OVER DENSE GRADED AGGREGATE, 4" THICK OVER

TOPSOIL, 5" THICK AND SODDING

ALL CURB RAMPS CONSTRUCTED SHALL MEET THE PROPOSED ACCESSIBILITY GUIDELINES FOR PEDESTRIAN FACILITIES IN THE PUBLIC RIGHT-OF-WAY (P.R.O.W.A.G.). DATED JULY 26, 2011

THE CONTRACTOR SHALL UTILIZE THE EXISTING ROADWAY AS A CONSTRUCTION ENTRANCE. THE ROADWAY SHALL BE CLEANED AS NEEDED OR AS DIRECTED BY THE CAMDEN COUNTY SOIL CONSERVATION DISTRICT AND THE BOROUGH ENGINEER, TO ELIMINATE TRAFFIC HAZARDS, DUST, ETC. (see soil conservation notes), LUMP SUM (N.S.P.).

ALL CONCRETE SIDEWALK DESIGNATED FOR REMOVAL, SHALL BE REMOVED TO THE NEAREST EXPANSION JOINT. IN LOCATIONS WHERE NO JOINTS EXIST, THE CONCRETE SIDEWALK SHALL BE SAWCUT, VERTICALLY, TO ALLOW FOR THE REMOVAL OF THE EXISTING SIDEWALK.

CRUSHED OR RECYCLED CONCRETE OR CRUSHED OR RECYCLED ASPHALT WILL NOT BE ACCEPTED AS A SUBSTITUTE TO DENSE GRADED AGGREGATE FOR THIS PROJECT

(N.S.P.) INDICATES NO SPECIFIC PAYMENT WILL BE MADE FOR THE ITEM. THE COST SHALL BE INCLUDED IN VARIOUS ITEMS IN THE PROPOSAL

THE CONTRACTOR SHALL NOT ENTER ONTO ANY PRIVATE PROPERTIES WITHOUT RECEIVING A "CONSENT TO ENTER AGREEMENT" FROM THE PROPERTY OWNER

> REV. DATE: DRWN. CHKD.

Cul-De-Sac Grading Plan

Reconstruction of Pelican Drive from Road 'B' to the Cul-De-Sac Station 9+50 to Station 13+60±

Borough of Audubon Park Camden County, New Jersey


 DATE: 02/06/23
 DRAWN BY: S.H./ T.H. | CHKD. BY:
 SCALE: AS NOTED

 PROJECT No. 40-40AP0521
 FIELD BOOK/PAGE:
 SHEET No. 4 OF 5

GREGORY BLASE FUSCO

PROFESSIONAL ENGINEER

NJPE No. 32853 PA.PE No. 036608-E NJ PROFESSIONAL PLANNER No. 4076

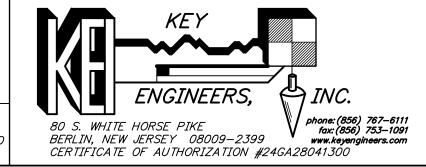

CONSTRUCTION AND MATERIALS SHALL CONFORM TO THE DEPARTMENT'S STANDARD SPECIFICATIONS FOR ROAD AND BRIDGE CONSTRUCTION, 2019 EDITION, WHICH IS INCORPORATED HEREIN BY REFERENCE, AS AMENDED AND SUPPLEMENTED, AND THE DEPARTMENT'S SUPPLEMENTARY SPECIFICATIONS FOR STATE AID PROJECTS, 2019 EDITION, WHICH IS INCORPORATED HEREIN BY REFERENCE, AS AMENDED AND SUPPLEMENTED. STANDARD CONSTRUCTION DETAILS SHALL CONFORM TO THE LATEST REQUIREMENTS OF THE DEPARTMENT OF TRANSPORTATION. THE NEW JERSEY DEPARTMENT OF TRANSPORTATION "STANDARD ROADWAY CONSTRUCTION/ TRAFFIC CONTROL/ BRIDGE CONSTRUCTION DETAILS" BOOKLET DATED 2016 AND "ELECTRICAL BUREAU STANDARD DETAILS, 2007" AND ALL BASELINE DOCUMENT CHANGES MADE TO THESE CONSTRUCTION DETAILS, SHALL GOVERN, EXCEPT FOR THOSE DETAILS CONTAINED HEREIN. PARTIALLY FUNDED THROUGH NEW JERSEY DEPARTMENT OF TRANSPORTATION MUNICIPAL AID PROGRAM, FY2022

